



A/23939/524/96


Planning Permit No. _____
APPROVED
 SUBJECT TO THE CONDITIONS IN THIS OFFICE LETTER.
 At 249/2496 Date 12-11-96
 FOR MEMBER SECRETARY,
 MADRAS METROPOLITAN
 DEVELOPMENT AUTHORITY
 MADRAS - 600 008.

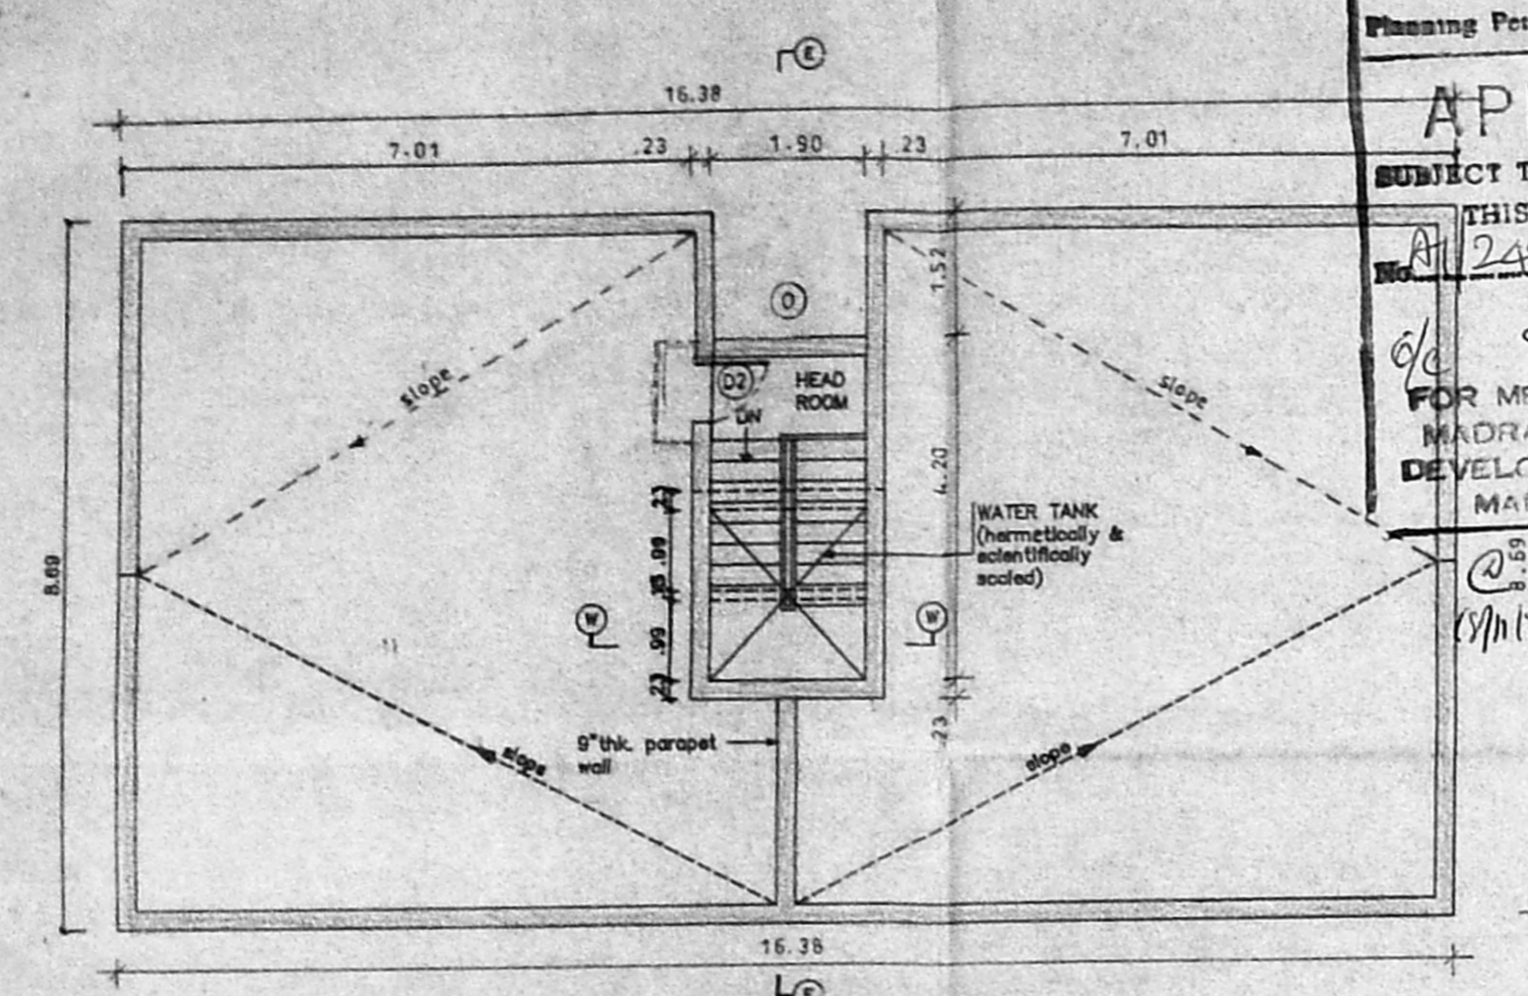

TERRACE FLOOR PLAN

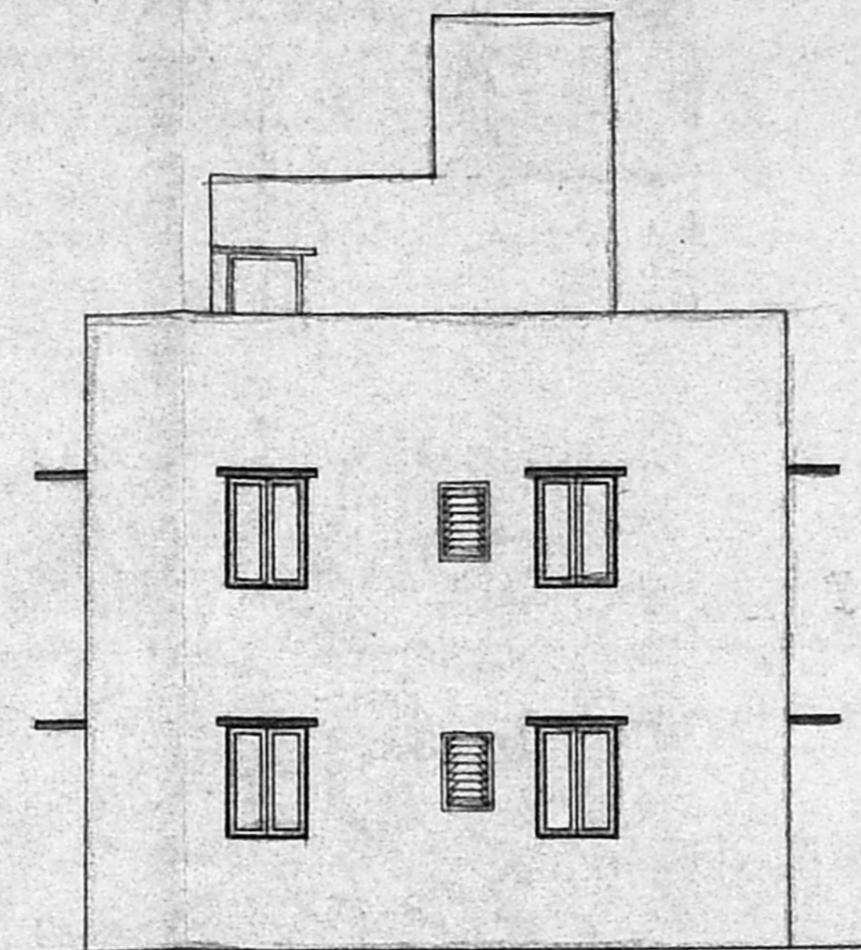


FRONT ELEVATION

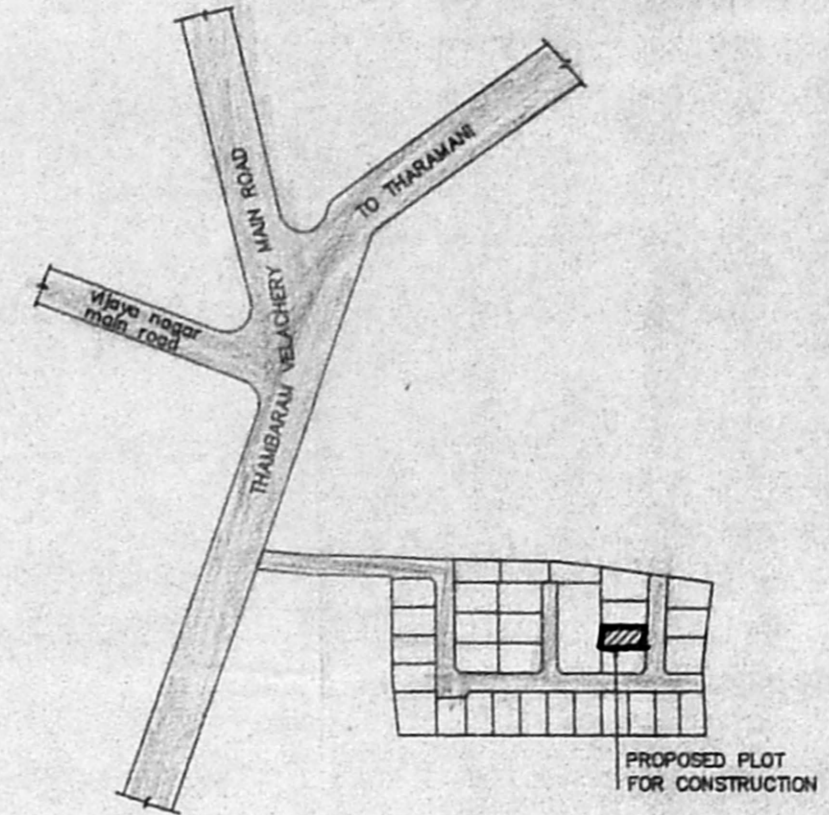


KEY PLAN
(not to scale)

LEGEND		
CODE	SIZE	DESCRIPTION
D1	0.99 x 1.981	TEAK WOOD FRAMED FLUSH DOOR
D2	0.91 x 1.981	COUNTRY WOOD FRAMED FLUSH DOOR
D3	0.76 x 1.981	COUNTRY WOOD FRAMED FLUSH DOOR
W3	1.775 x 1.37	STEEL GLAZED WINDOW
W6	1.475 x 0.875	STEEL GLAZED WINDOW
W9	0.975 x 1.37	STEEL GLAZED WINDOW
V2	0.61 x 0.94	STEEL GLAZED VENTILATOR
O	1.9 x 1.07	OPENING


SPECIFICATION	
SL.NO	DESCRIPTION
1.	P.C.C. 1:4:8 IN FOUNDATION
2.	SAND FILLING IN FOUNDATION
3.	BRICK WORK IN C.M. 1:6
4.	R.C.C. WORK FOR SLABS, LINTELS & BEAMS Etc.,
5.	PLASTERING IN C.M. 1:5 EXTERNAL & 1:4 INTERNAL
6.	MOSAIC TILED FLOORING.
7.	WEATHERING COURSE OF BRICK JELLY LIME CONC.
8.	CONCRETE BLOCK INFILL.

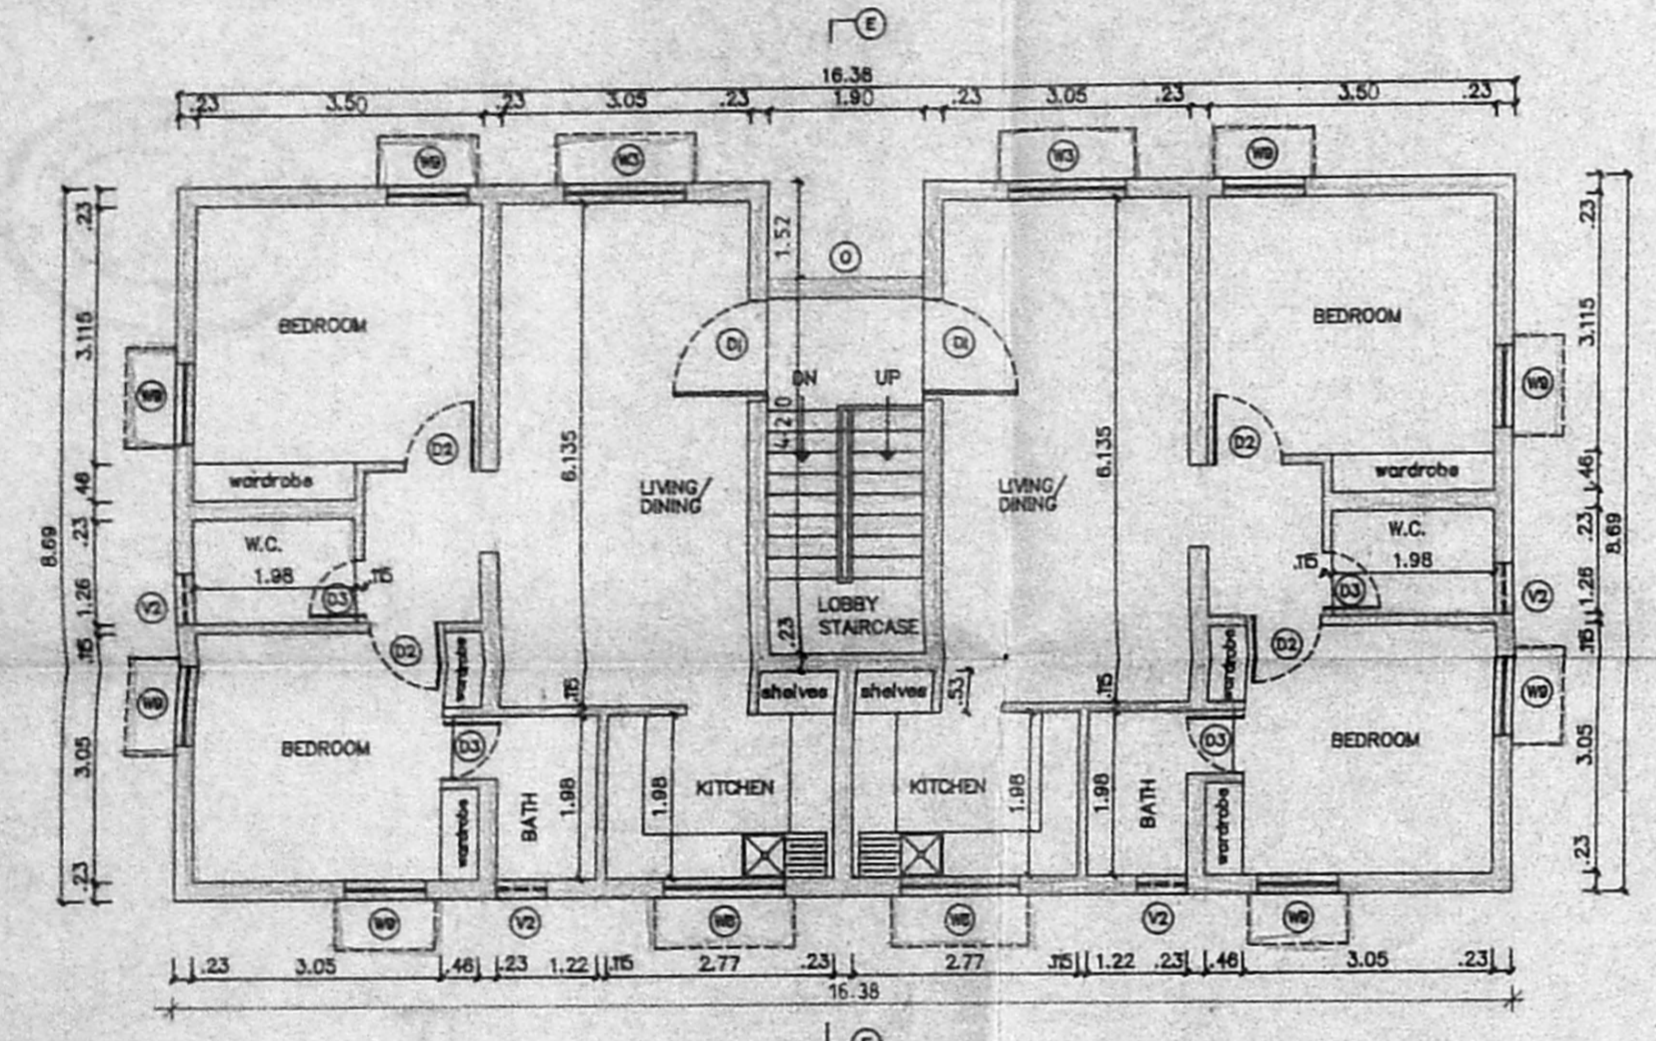


FIRST FLOOR PLAN

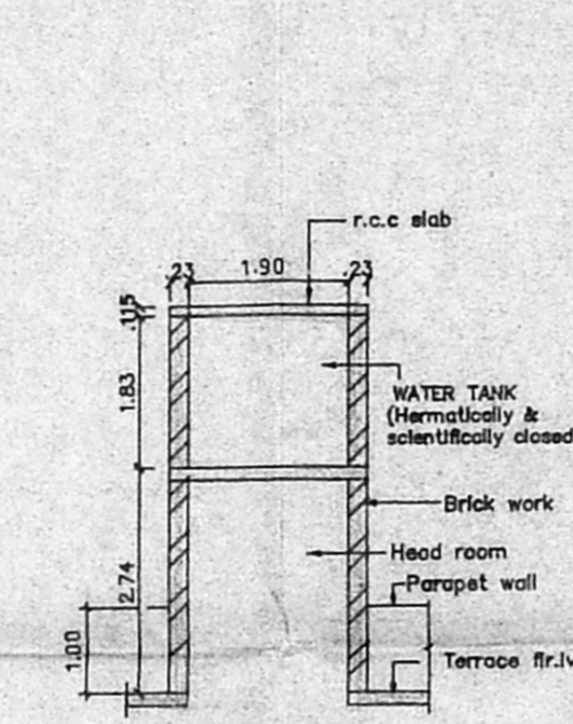

SECTION WW
SECTION OF WATER TANK
SCALE 1:100

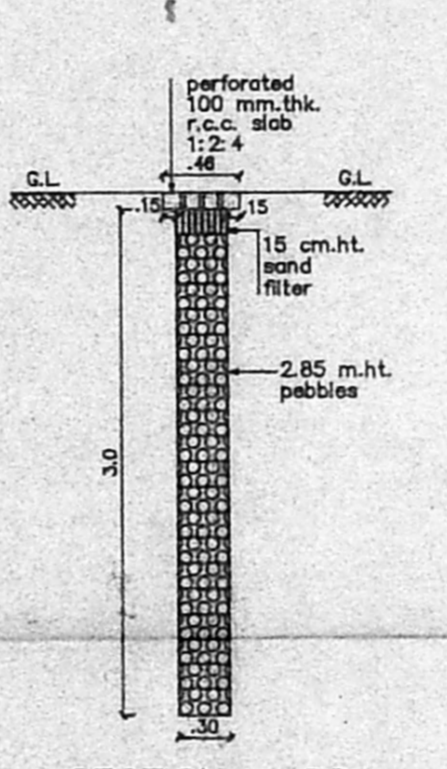

SECTION - DD
PERCOLATION PIT
SCALE 1:50

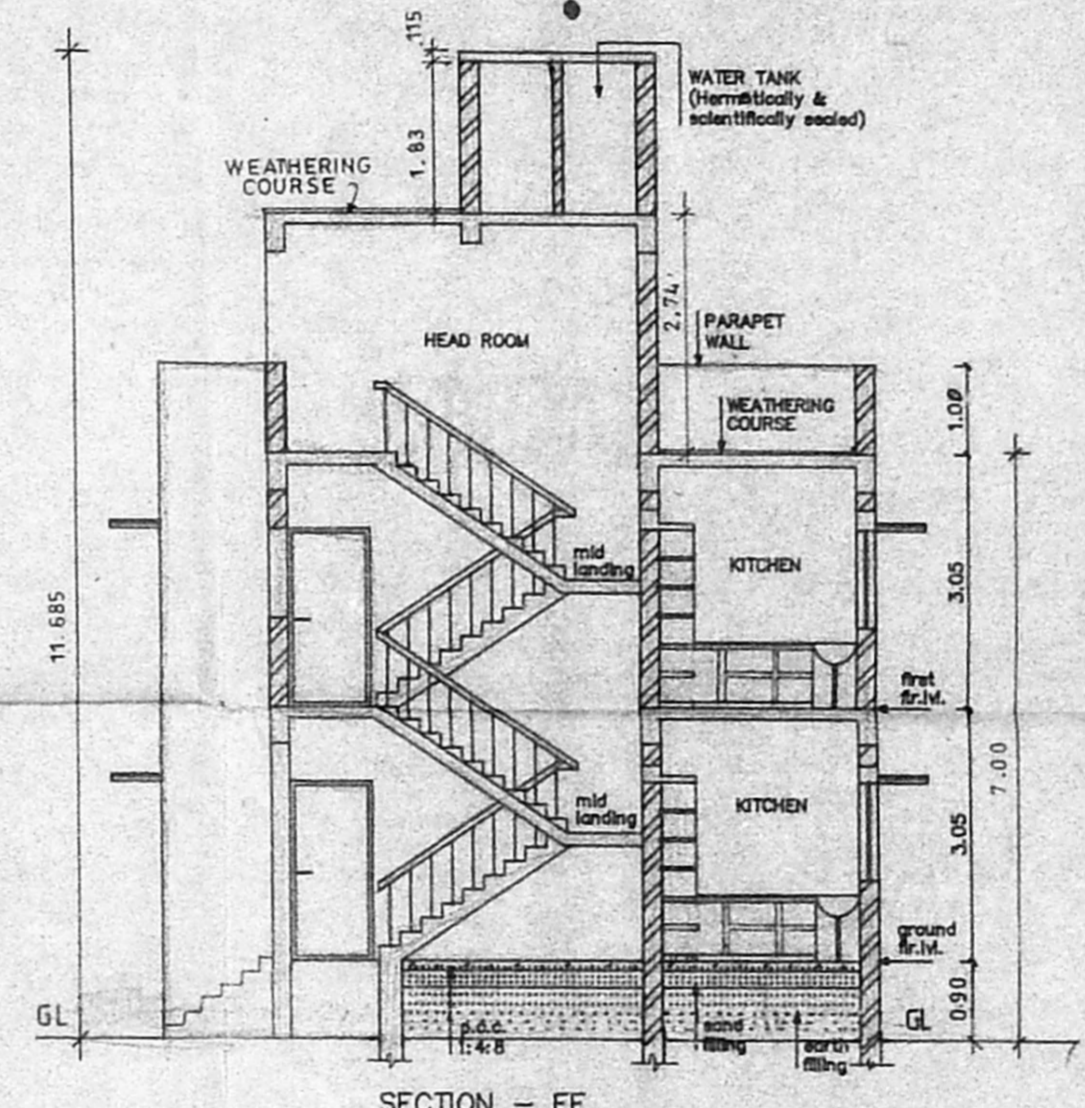

SECTION - EE

AREA STATEMENT

PLOT AREA	258.03 M ²
BUILT UP AREA	278.9084 M ²

COLOUR INDEX

PROPOSED CONSTRUCTION	●
BOUNDARY OF SITE	●
ROAD	●

R.No	DATE	REVISIONS	INITIAL

1 151 179 M	09-02-94	1 : 100	SPIC	JACOR28	Jones	5.11.96
DRG No.	DATE	SCALE	FILE	DRAWN	CHECKED	

PROPOSED CONSTRUCTION OF DWELLING UNITS IN PLOT No : 28, L.A. No 3/95 DT. 05-06-95 AT SURVEY Nos. 249/3, 250/2, 250/3, 251/5, 254/4 & 328/1, (VILLAGE VELACHERY) VELACHERY, TAMBARAM ROAD, MADRAS - 600 042. TALUK : MAMBALAM - GUINDY, CORP. DIV. NO. 153 ZONE. X

OWNER'S SIGNATURE


[Signature]
 DR. DURRAMANNA
 S.L., A.L., Genl. Insp.
 Chennai Civil Engineer
 Licensed Surveyor - Class-1

L.S. No : 306 95/96


LICENSED SURVEYOR




SHEET NO :

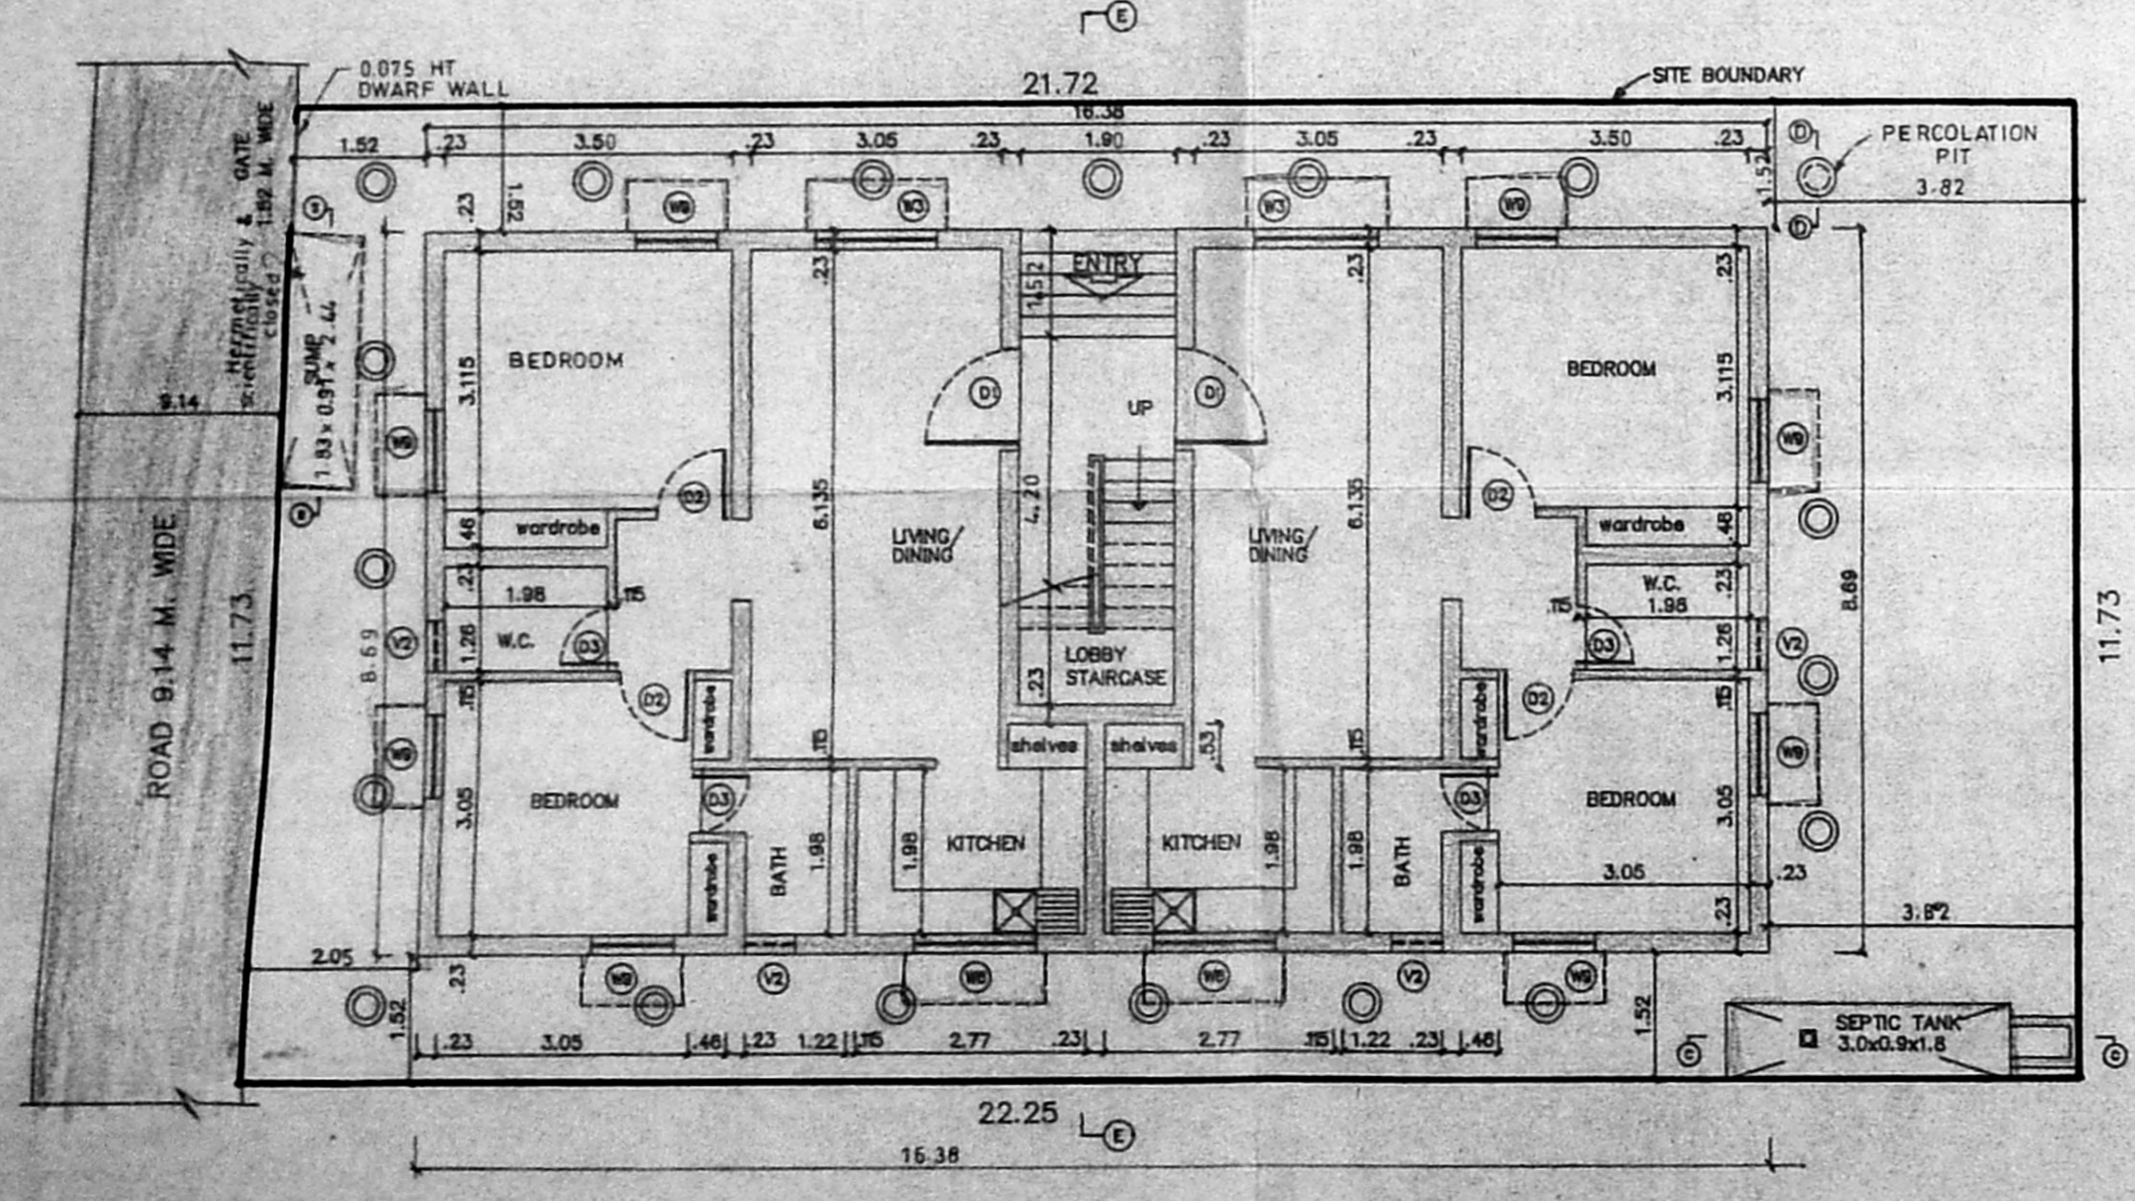


SITE CUM GROUND FLOOR PLAN

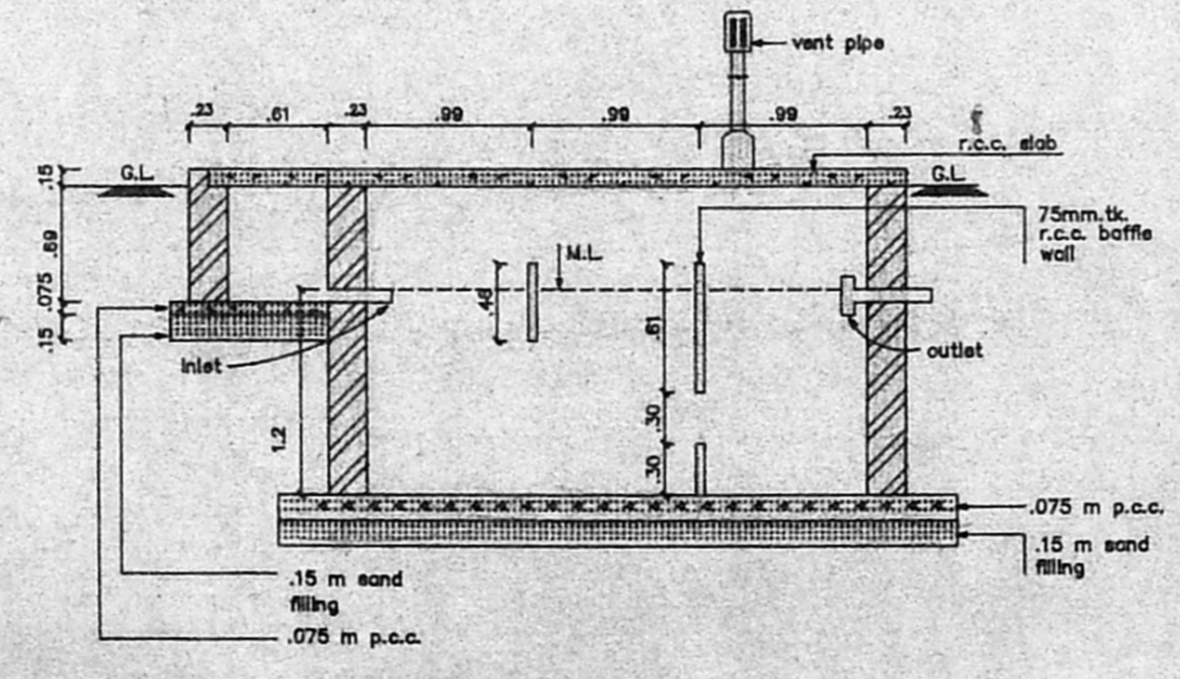


SECTION - CC
SEPTIC TANK
SCALE 1:100

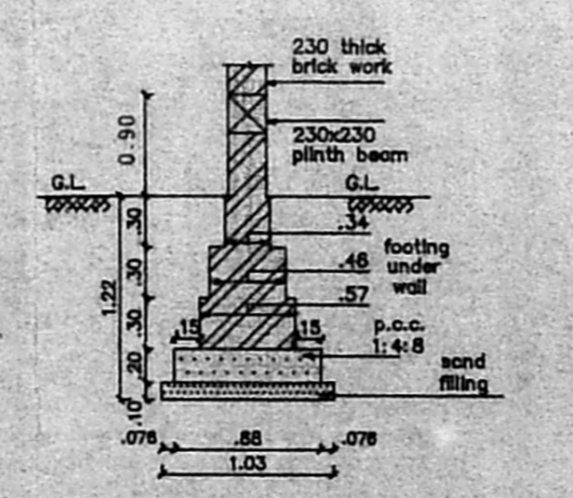

SECTION OF FOUNDATION
SCALE 1:50

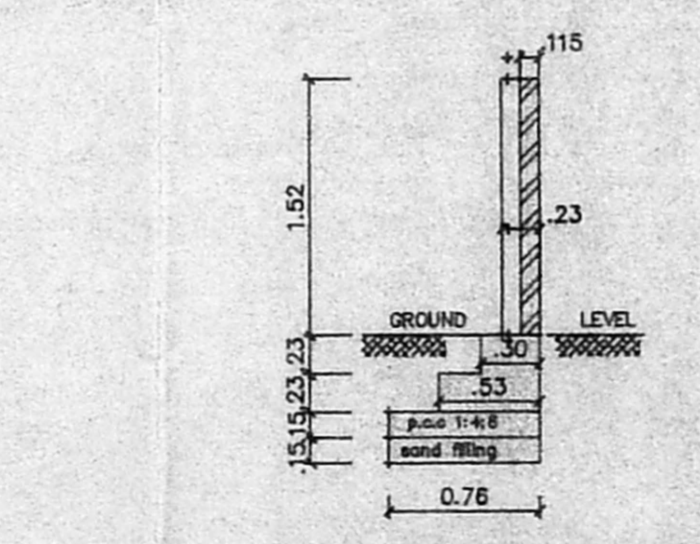

SECTION OF
COMPOUND WALL
SCALE 1:50

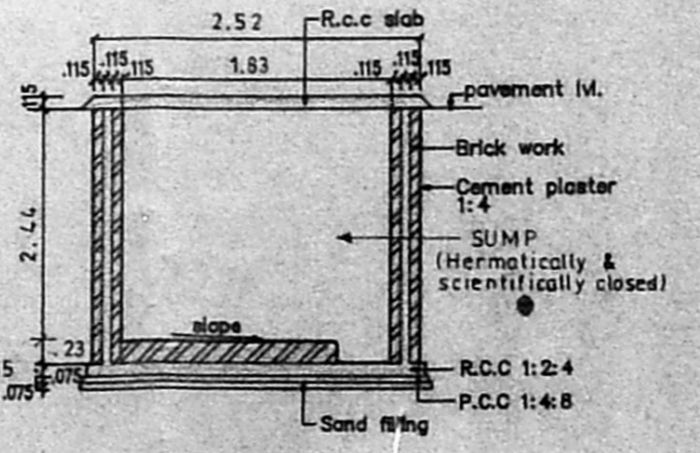

SECTION SS
SECTION OF SUMP
SCALE 1:100